21.17 | 45.00% | 19.00% | Pass

22.17 45.00% 21.00% Pass

32 47.25 21.50 1015.88 *201.96*

33 47.25 4.58 216.56 *47.48*

DENOTES ANSI "TYPE A" ACCESSIBLE (I.E., "FULLY HC ACCESSIBLE") UNIT. REFER TO SITE/CIVIL, REFER TO BUILDING FLOOR PLANS, UNIT PLANS AND ACCESSIBILITY NOTES & DIAGRAMS FOR MORE INFORMATION. REFER TO TABLE BELOW FOR QUANTITIES OF HC **HC** PER 2018 NCSBC SECTION 1107.6.2.1.1: 5% OF UNITS = <u>14</u> HC TOTAL HC UNITS REQUIRED = 14**DISTRIBUTION OF HC UNITS:** DENOTES FRONT ELEVATION OF BUILDING (PER A2 SHEETS). SECTION A 2 HC UNIT SECTION B 0 HC UNIT SECTION C 2 HC UNIT SECTION D 6 HC UNIT SECTION E TOTAL = 4 HC UNITS 14 HC UNITS

NOTE: ACCESSIBLE ROUTE(S) NOT TO EXCEED 2% CROSS SLOPE WITH 8.33% MAXIMUM RUNNING SLO


NOTE: REFERENCE CIVIL DRAWINGS FOR UPDATED

PARKING LOT INFORMATION AND HANDICAP SPOT

REFER TO A1.01 - A1.1.24 FOR BUILDING SPECIFIC

HANDICAP UNIT LOCATIONS.

NOTE: ACCESSIBLE ROUTE(S) NOT TO EXCEED 2% CROSS SLOPE WITH 8.33% MAXIMUM RUNNING SLOPE. HANDRAILS ARE TO BE PROVIDED ON BOTH SIDES OF RAMP WHEN SLOPE IS BETWEEN 5-8.33% OVER AN ELEVATION CHANGE GREATER THAN 6 INCHES.

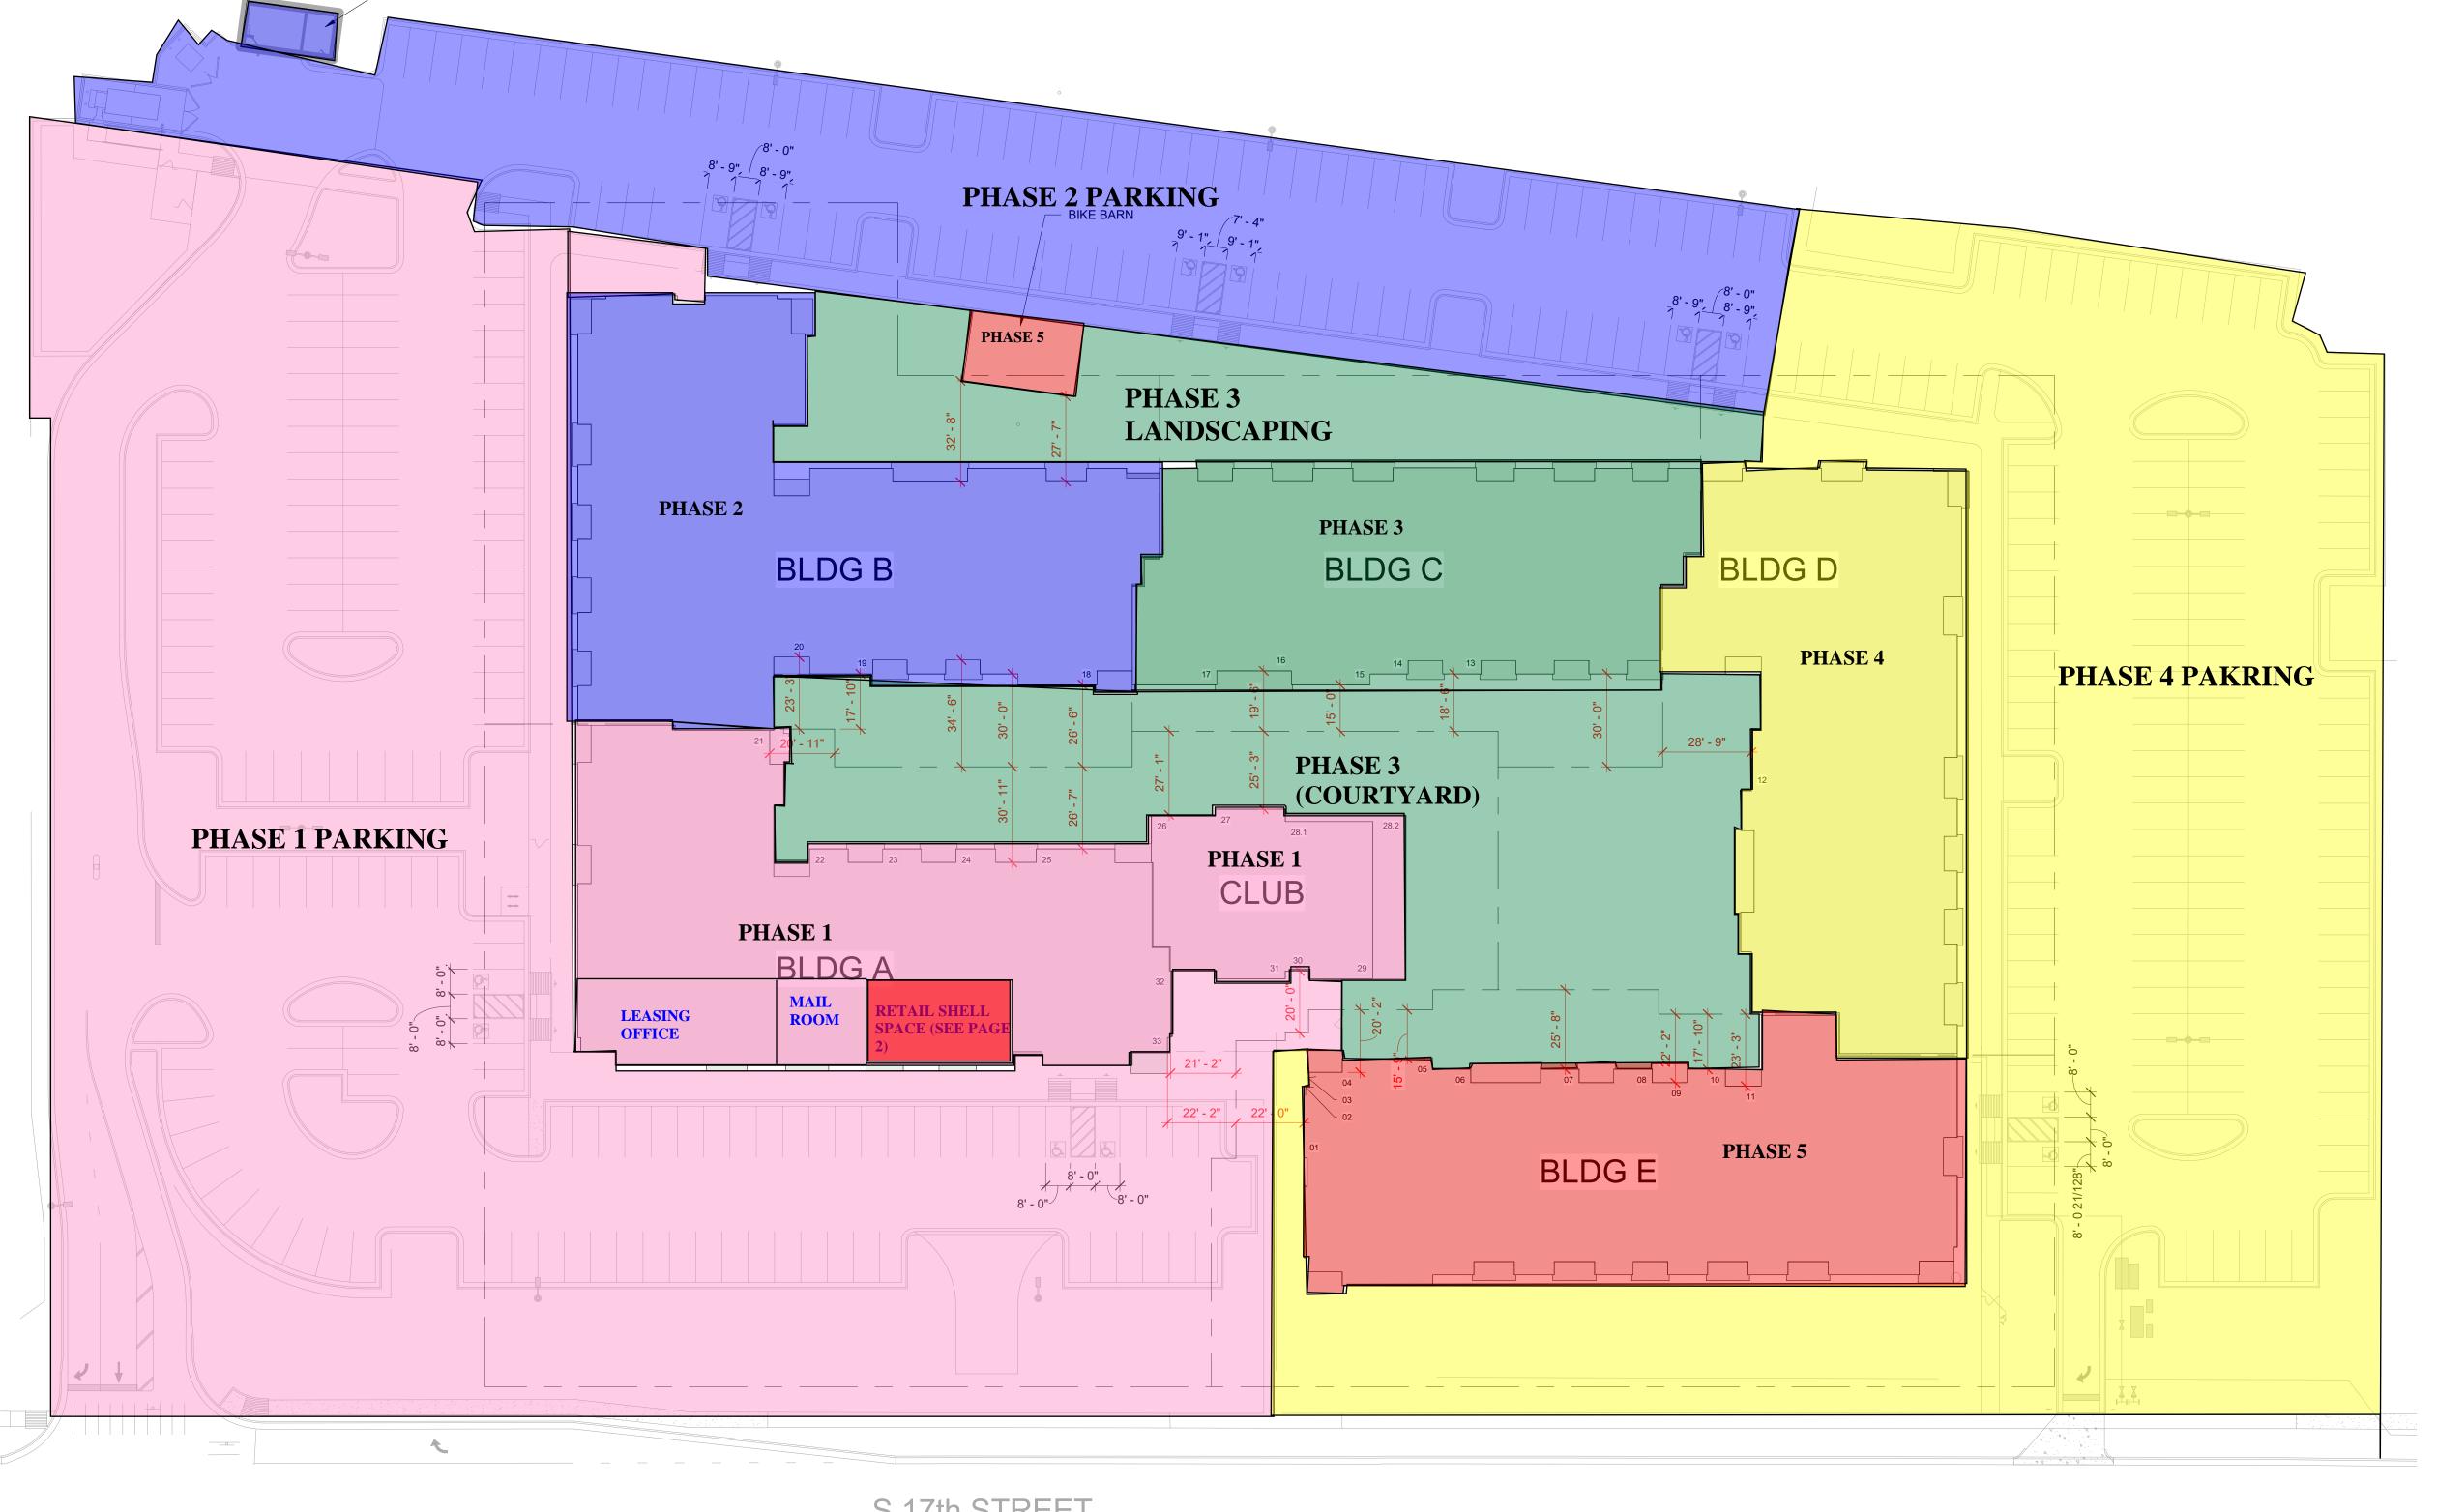

S 17th STREET

- MAINTENANCE/DOG WASH

ARCHITECTURAL SITE PLAN
1" = 30'-0"

G1.02 IRN022

DPJ RESIDENTIAL


17 SOCIAL
WILMINGTON, NORTH CAROLINA


2923 South Tryon St., Suite 130

Charlotte, NC 28203

ClineDesignAssoc.com

704/333.7272

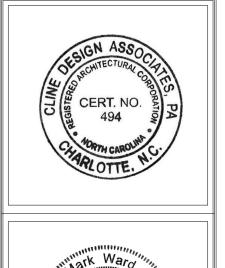

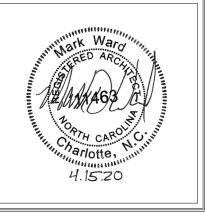

PROJECT: 219039
DATE: 03.16.20
REVISIONS: DATE

DRAWN BY: Author
CHECKED BY: Checker

ARCHITECTURAL SITE PLAN

SYMBOL LEGEND

- - WALKING SURFACE
 - EJ EXPANSION JOINT @ BRICK, TYP. 3/8" NEOPRENE W/ BACKER ROD & (REFER TO FLOOR PLANS AND ELEVATIONS FOR LOCATIONS. FINAL

MASONRY CONTRACTOR AND APPROVED BY ARCHITECT)

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- 1. MASONRY CONTRACTOR TO PROVIDE HORIZONTAL AND VERTICAL EXPANSION JOINTS IN BRICKWORK PER TECHNICAL NOTES 18A AS PUBLISHED BY THE BRICK INDUSTRY
- 2. ATTACHMENT TO MASONRY SHALL BE PER TECHNICAL NOTES 44A AS PUBLISHED BY THE BRICK INDUSTRY ASSOCIATION.

CONC. SLAB JOINTS

- * ALL JOINTS TO BE CONFIRMED/ COORDINATED WITH STRUCTURAL DRAWINGS, NOTES, SPECIFICATIONS,
- PROVIDE ISOLATION JOINTS (EXPANSION JOINTS) AT ALL SLAB TO COLUMN, SLAB TO WALL, OR SLAB TO
- DISSIMILAR MATERIAL LOCATIONS. 2. PROVIDE CONSTRUCTION JOINTS AS REQUIRED. JOINTS TO EITHER BE KEYED OR DOWELED. PREVENT
- 3. PROVIDE CONTROL JOINTS IN EXPOSED CONCRETE SLABS AT 15' TO 20' O.C. EA. WAY OR WHEREVER REQUIRED TO "BREAK" AN IRREGULAR SHAPED SLAB INTO SQUARE OR RECTANGULAR SECTIONS.

GENERAL NOTES

- 1. NO MASONRY CORE HOLES SHALL BE EXPOSED, TYP. CLOSURE (SOLID CORE) MASONRY SHALL BE USED WHERE CORE HOLES WOULD OTHERWISE BE EXPOSED TO ELEMENTS. 2. EXPOSED STEEL LINTELS AND BREAK
- METAL TO BE PAINTED TO MATCH ADJACENT SURFACE UNLESS OTHERWISE NOTES, TYP. 3. ALL EXTERIOR GWB CEILINGS TO BE
- PAINTED UNLESS OTHERWISE NOTED. . SEE 'G' SERIES FOR LIFE SAFETY INFORMATION.
- WALL CAVITY SEGMENTS BEHIND ALL EXTERIOR LIGHTS AND SIGNAGE. 6. FACE OF SLAB SHALL NOT BE EXPOSED AT SLOPED EXTERIOR PAVING CONDITIONS. COORDINATE EXT. PAVING CONDITIONS WITH CIVIL, TYP.
- 7. EXTERIOR PAVING SHALL NOT HAVE A FINISHED ELEVATION HIGHER THAN THE SILL HEIGHT AT AN ADJACENT DOOR LOCATION.
- 8. ALL CAULKING IS TO MATCH ADJACENT SURFACES.
- 9. ALL DIMENSIONS ARE TAKEN FROM EXTERIOR FACE OF STUD WALLS, EXTERIOR FACE OF CMU/CONCRETE WALLS, COLUMNS, WINDOW CENTERLINES, & MASONRY OPENINGS
- 10. PROVIDE 3/4" PLYWOOD WITHIN WALL CAVITY SEGMENTS BEHIND ALL SURFACE MOUNTED ELECTRICAL PANELS PRIOR TO PANEL INSTALLATION.
- (F.F.E.) WITH CIVIL DRAWINGS. NOTIFY ARCHITECT IF FINAL GRADE IS LESS $\stackrel{\cdot}{\longrightarrow}$ THAN 6" BELOW BUILDING SLAB. 12. SEE EXT. ELEVATIONS FOR LOCATION & TAGS OF EXTERIOR FINISHES. 13. COORDINATE SIDEWALK LOCATIONS AND HEIGHTS WITH ALL HARDSCAPE PLANS. ALL SIDEWALKS AT DOOR THRESHOLDS SHALL BE LEVEL TO 1/2" LOWER MAX & HAVE A POSITIVE SLOPE AWAY FROM THE BUILDING @
- 14. VERIFY ALL BRACE FRAME LOCATIONS & CONFIGURATIONS ARE CLEAR OF ALL DOOR AND WINDOW OPENINGS. 15. SEE UNIT PLANS (A4.00 SERIES) FOR
- UNIT DOOR TAGS & WINDOW TAGS. 16. ALL EXTERIOR BALCONIES & WALKS TO SLOPE 1/4" PER 1'-0" AWAY FROM UNIT DOORS.
- 17. SEE MEP, FPE, CIVIL, AND STRUCTURAL DRAWINGS FOR ADDITIONAL INFORMATION. 18. SPOT ELEVATIONS INDICATED ARE FOR ARCHITECTURAL COORDINATION
- ONLY. SEE CIVIL DRAWINGS FOR ACTUAL SITE SPECIFIC ELEVATIONS. 19. FIRE RATED SEPARATIONS TO EXTEND INTO ALL EAVES & DORMERS
- AT TENANT SEPARATION. 20. ALL EXTERIOR ACCESSED STORAGE CLOSETS, MECHANICAL CLOSETS, SPRINKLER ROOMS AND ANY OTHER
- EXTERIOR ACCESSED UNCONDITIONED SPACE: AT ALL INTERIOR WALLS OF SPACE PROVIDE MOLD & MILDEW RESISTANT GWB. FIRE RATINGS AS SHOWN ON PLANS MUST BE MAINTAINED. 21. ALL WINDOWS OPENING ONTO
- COURTYARD DECK AREA MUST BE LTD. TO A 4" MAX. OPENING OR BE FIXED. 22. COMMON REST ROOMS IN BLDG C TO HAVE SHATTERPROOF MIRRORS (IF MIRRORS PROVIDED).
- 23. IN COMMON RESTROOMS, LAVATORIES AND SHOWERS MUST HAVE METAL OR
- PLASTIC DISPENSERS. 24. 110 DEGREE MAX. HOT WATER MUST BE AVAILABLE IN BLDG C COMMON
- RESTROOMS. 25. ALL STRUCTURAL STEEL (BEAMS AND COLUMNS) TO BE PROTECTED WITH INTUMESCENTPAINT, RATED PER REQUIRED SEPARATION AND/OR
- PREFERRED METHOD 26. DOOR LOCATION TO BE 4" FROM PERPENDICULAR STUD U.N.O. ON

DATE: 03.16.20 DATE **REVISIONS:** GC & MIS Items 4/20/20 P2 Permit Comments 4/29/20 P3 Pool Permit 07/20/20 Sub. 142100.01 6/22/20 ADA Unit Changes 7/16/20 Owner Comments 7/20/20 RFI 007 P4 Pool Permit 8/13/20 10 Unit Ref. 09/04/20 19 Coordination 03/29/21 DRAWN BY: TRP

CHECKED BY: MW

FIRST FLOOR

BUILDING PLAN

A1.01 IRN #040